

PROPOSED ALTERATIONS & EXTENSION

RD & LM HARRIS 10 MARY STREET, SCOTTSDALE, TAS 7260



ARCHITECTURAL DRAWING INDEX

SHEET NAME A0.0 COVER SHEET A0.1 SHEET NOTES A1.0 SITE PLAN

A1.1 EXISTING FLOOR PLAN A1.2 FOOTING PLAN A1.3 FRAMING PLAN

PROPOSED FLOOR PLAN A1.5 PROPOSED DEMOLITION

A1.6 ELECTRICAL PLAN **ROOF PLAN**

ELEVATIONS A2.1 SECTIONS (1/2) A3.1

A3.2 SECTIONS (2/2) A4.1 WINDOW & DOOR SCHEDULE

A5.0 **DECK DETAILS**

AX1 WATER PROOFING & WET AREAS

WATER PROOFING & WET AREAS - UNENCLOSED

AX3 STANDARD TIE DOWN DETAILS AX4 SAFETY NOTES

AX5 **SAFETY NOTES 2**

PLANNING SCHEME DATA

LOCAL AUTHORITY: LAND TITLE REFERENCE: PROPERTY IDENTIFICATION (PID): PLANNING ZONE:

PLANNING CODES

DORSET COUNCIL SP 61108 FOLIO 8

6840529 GENERAL RESIDENTIAL

TASMANIAN PLANNING SCHEME

CONSULTANTS & AUTHORITIES

THE FOLLOWING REPORTS, DOCUMENTS AND APPROVALS FORM THE OVERALL SCOPE OF WORK TO CONSTRUCT THIS PROJECT. THEY MUST BE READ IN

CONSULTANT / AUTHORITY ARCHITECTURAL DESIGN MODULOS DESIGN

DOCUMENT ID

CONSTRUCTION DATA

NCC BUILDING CLASSIFICATION: 10A **DESIGN WIND SPEED:** N2

SOIL CLASSIFICATION: **EXISTING AS 2870 2.2.2** CLIMATE ZONE:

BUSHFIRE ATTACK LEVEL: ALPINE AREA (900M ABOVE AHD): N/A CORROSION ENVIRONMENT: NO OTHER KNOWN SITE HAZARDS: NO

AREA ANALYSIS

SIZE **AREA NAME** SITE AREA: 1214m2 **BUILDING FOOTPRINT:** 163m2 (NEW BUILD): 40m2

revision: description: date:



MODULOS DESIGN

RD & LM HARRIS

Transforming Visions into Reality 10 MARY STREET, SCOTTSDALE, TAS 7260

Project Name:

PROPOSED ALTERATIONS & EXTENSION

Sheet Name: COVER SHEET Project No: 3022

Designer: Designer

CC2319 H


Total sheets:

CURRENT REV

🕓 0402 984 082 @ modulosdesign.com.au 🖸 drafting@modulosdesign.com.au

© Copyright Modulos Design 2023



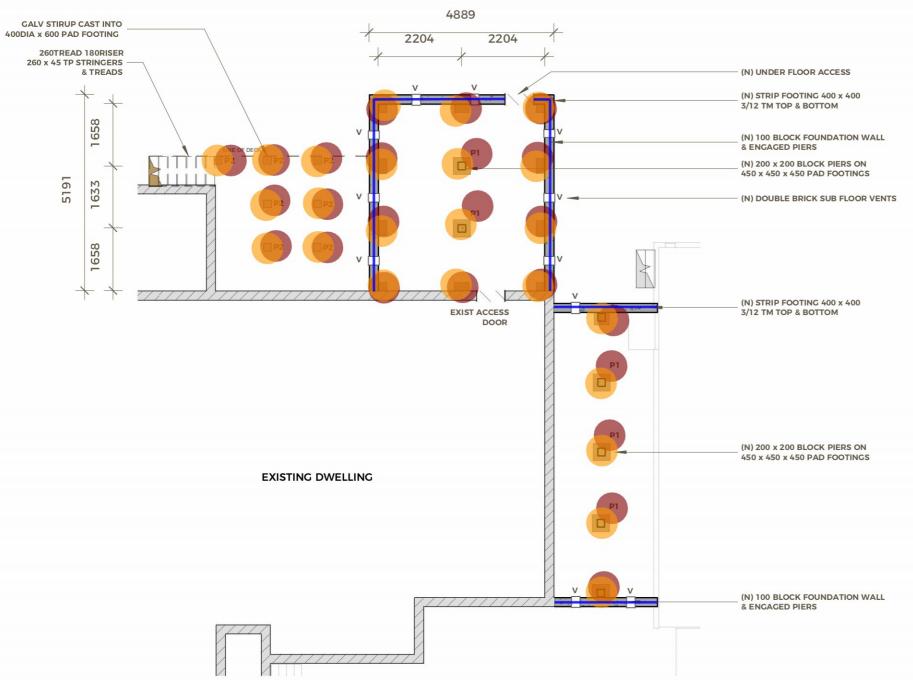

FOOTINGS

CONCRETE FOOTINGS AND SLABS IN ACCORDANCE WITH PART 3.2 OF CURRENT NCC AND AS 2870.1 SECT 2.2.2 (B)

UNLESS OTHERWISE SPECIFIED, FOOTINGS 25MPA / SLAB 25MPA. STRIP FOOTINGS TO BE PLACED WITH A MECHANICAL VIBRATOR.

CONCRETE SLABS TO BE MOISTURE CURED FOR MIN. OF 7 DAYS OR APPLY APPROVED CURING COMPOUND.

PROVIDE WALL CAVITY DRAINAGE WITH WEEP HOLES AT 960 MAX CENTRES ALONG LINE ABOVE FINISHED GROUND LEVEL. (SLAB AREA).

BRICK AND BLOCKWORK

IN ACCORDANCE WITH PART 3.3 OF CURRENT NCC, AS 4773 AND AS 3700

DAMP PROOFING

IN ACCORDANCE WITH PART 3.3.4 OF CURRENT NCC AND TO AS/NZS 2904.

FOOTING DETAIL

P1 PAD FOOTINGS

450 X 450 X 450 CONCRETE PAD FOOTING

P2 PAD FOOTINGS

400DIA X 600 CONCRETE PAD FOOTING 90X90 TP POST - 2/M12 GALV BOLTS TO **GALV STIRUP CAST INTO FOOTING**

STRIP FOOTINGS

100 BLOCKWORK WALL & ENGAGED PIERS 400 X 400 STRIP FOOTING TRENCH MESH L11TM3 TOP & BOTTOM

TIE NEW FOOTINGS TO EXISTING M12X400 CHEMSET INTO **EXISTING FOOTINGS 600 CENTERS**

SUB FLOOR VENTS

DOUBLE BRICK VENTS 2500 CENTERS 600 FROM CORNERS

FOUNDATION PLAN SCALE: 1:100

P1: 450mm x 450mm x 450mm Pad Footing P2: 400 Dia x 600mm Concrete Pad Footing •200mm x 200mm x 600mm Block Pier 400mm x 400mm Strip Footing 3/12 TM Top & Bottom 100mm Block Foundation Wall (0.6m H)

17.0 EA 7.0 EA 24.0 EA 19.6 M 19.6 M



MODULOS DESIGN RD & LM HARRIS

PROPOSED ALTERATIONS & EXTENSION

Project No: 3022

Designer

Sheet No:

Total sheets:

● 0402 984 082 ● modulosdesign.com.au drafting@modulosdesign.com.au

FOOTING PLAN

Sheet Name:

TIMBER FRAMING

ALL TIMBER ENGINEERED PRODUCTS TO BE INSTALLED IN ACCORDANCE WITH MANUFACTURERS INSTRUCTIONS. CHECK ALL DIMENSIONS & SPECIFICATIONS WITH MANUFACTURER BEFORE ORDERING ANY MATERIALS.

PROTECTADECK OR MALTHOID WATERPROOF CAPPING TO PREVENT WATER PONDING ON H3 TREATED AND PAINTED JOISTS AND BEARERS

ALL FRAMING ANCHORS FIXED WITH PRYDA 35x3.15 HD GALV. TIMBER CONNECTOR NAILS.

5191

120 x 45 TP Joists @ 450mm CTRS

🕎 90 x 45 MGP 12 Joists @ 450mm CT... 42.6 sq M

ALL STAIRS & STEPS TO BE CONSTRUCTED IN ACCORDANCE WITH NCC 3.9.1 TYPICAL.

ALL JOISTS TO HAVE 42mm END BEARING MINIMUM & 58mm BEARING @ ALL INTERNAL SUPPORTS.

PROVIDE BLOCKING TO DEEP JOISTS IN ACCORDANCE WITH CLAUSE 4.2.2.3 AS-1684.2. DEEP JOIST IS WHERE THE DEPTH OF THE JOIST IS EQUAL TOO, OR GREATER THEN 4 TIMES THE

BUILDER TO CHECK ALL FALLS AND LEVELS IN WET AREAS. (PRIOR TO COMMENCEMENT OF WATERPROOFING). IN ACCORDANCE WITH N.C.C. 3.8.1.

4649

2/ 140x35 TP BEARERS

14.8 SQ M

36.1 M

8.2 M

25.1 M

16.4 M

7.0 EA

49.0 M

12.6 M

45.6 M

62.5 SQ M

2/ M12 GALV BOLTS TO POSTS

2830

ALL SERVICES TO BE LOCATED ON SITE PRIOR TO COMMENCEMENT OF ANY WORKS.

ALL DIMENSIONS & RDLs APPROXIMATE & TO BE CONFIRMED ON SITE BY SURVEYOR PRIOR TO COMMENCEMENT OF WORK

NOTIFY COUNCIL AUTHORITIES & STRUCTURAL ENGINEER IF ANY VARIATION IN BUILDING SETOUT OCCUR.

I) 120 x 35 MGP 12 BEARE

(N) 120 x 35 MGP 12 BEARER

(N) 2/120 x 35 MGP 12 SCREW LAMINATED BEARERS

(N) 90 x 45 MGP12 JOISTS

(N) 120 x 35 MGP 12 BEARER

@ 450 CTRS

IGP 12 Bearer 25.14 M (1 @ 5.05 M) 1 @ 4.99 M)

(1 @ 7.59 M)

1 @ 7.51 M)

Bearer 12 58 N

B M)

PROPOSED ALTERATIONS & EXTENSION

ALL DECKS, RAMPS, STAIRS, MEZZANINE FLOORS, RETAINING WALLS, EMBANKMENTS, ACCESS BRIDGES OR THE LIKE ALONG DELINEATED ACCESS PATHS 1000 ABOVE NGL TO HAVE 1000 HIGH BALUSTRADE TO NCC 3.9.2.2 & AS1170.1 TYPICAL.

PLATES

90X35 MGP10 OR 90X45 MGP10

90X35 OR 90X45 F5 PINE AT 600 MAX. CTRS.

JAMBS

2/90X45 MGP10

NOGGINS

70X35 MERCHANT AT 1350 CRS (OR MGP10 WHERE SPECIFIED ON PLANS/WHERE APPLICABLE).

** Bottom plate to be placed on H/D polyethylene damp-course **

INTERIOR NOTES

PLASTERBOARD

ALL INTERNAL PLASTERBOARD FINISHES TO BE IN ACCORDANCE WITH AS/NZS 2588

JOINERY

HARDWOOD IN ACCORDANCE WITH AS 2796 SOFTWOOD IN ACCORDANCE WITH AS 4785 PLYWOOD IN ACCORDANCE WITH AS/NZS 2270 AND AS/NZS 2271

CERAMIC TILING

IN ACCORDANCE WITH AS 4662, AS 2358 AND AS 4992 WATERPROOFING / WET AREAS:

IN ACCORDANCE WITH AS 3740 WATERPROOFING MEMBRANE AND SUBSTRATES TO BE INSTALLED TO FLOORS, WALLS AND WALL/FLOOR JUNCTIONS IN ACCORDANCE WITH AS 3740

WATERPROOFING OF DOMESTIC WET AREAS.

WALLS AND FLOORS OF SHOWERS, BATHS, LAUNDRIES AND TOILETS, SPLASH BACKS AND FLOOR WASTES TO NCC CLAUSE 3.8.1.2 'WATER RESISTANCE REQUIREMENTS'.

ALL AREAS TO BE LINED WITH RESILIENT 'VILLABOARD' OR SIMILAR PRODUCT.

BRACING NOTES

TYPE D DOUBLE DIAGONAL METAL TENSION STRAPS TO AS-1684. MIN BASE LENGTH 1800mm @ 3 kNm-1 5.4 kN

TYPE H METHOD B PLYWOOD SHEET BRACING TO AS-1684. MIN. BASE LENGTH 900mm @ 6 kNm-1 5.4 kN

TIE DOWNS

TIE DOWN

BATTENS TO TRUSSES 75 LONG SCREWS TRUSSES TO PLATES EACH BEARING

1/30 X 1.0 GL LOOPED STRAP 4/2.8DIA NAILS

PLATES & STUDS

1800C & EACH OPENINGS

1/30 X 1.0 GL LOOPED STRAP 4/2.8DIA NAILS

PLATE TO FLOOR

1/30 X 1.0 GL LOOPED STRAP 1800 CL

JOISTS TO BEARERS

2 PRYDA TRIPLE GRIP [1 EACH SIDE] EACH BEARING

BEARER TO POSTS

2/M12 GALV BOLTS

ALL FRAMING ANCHORS FIXED WITH PRYDA 35X3.15 GALV. TIMBER CONNECTOR NAILS.

revision: description: date:



MODULOS DESIGN

Standard Joist

140x35 TP Bearers

(2)/ M12 Galv Bolts

Standard Joist

Standard Joist

120x35 MGP 12 Bearer

(2) 140x35 TP Bearers

(2) 120x35 MGP 12 Bearer

19mm Treated Pine Decking Floor

RD & LM HARRIS

NEW TIMBER DECK

CLOSE JOINTEL

140x35 TP Bearers 16.42 M (1 @ 4.11 M) (1 @ 4.1 M)


Project Name:


Sheet Name: FRAMING PLAN Project No:


Designer: вмн

Total sheets:

3022 CBOS Licence: 631009560

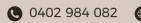

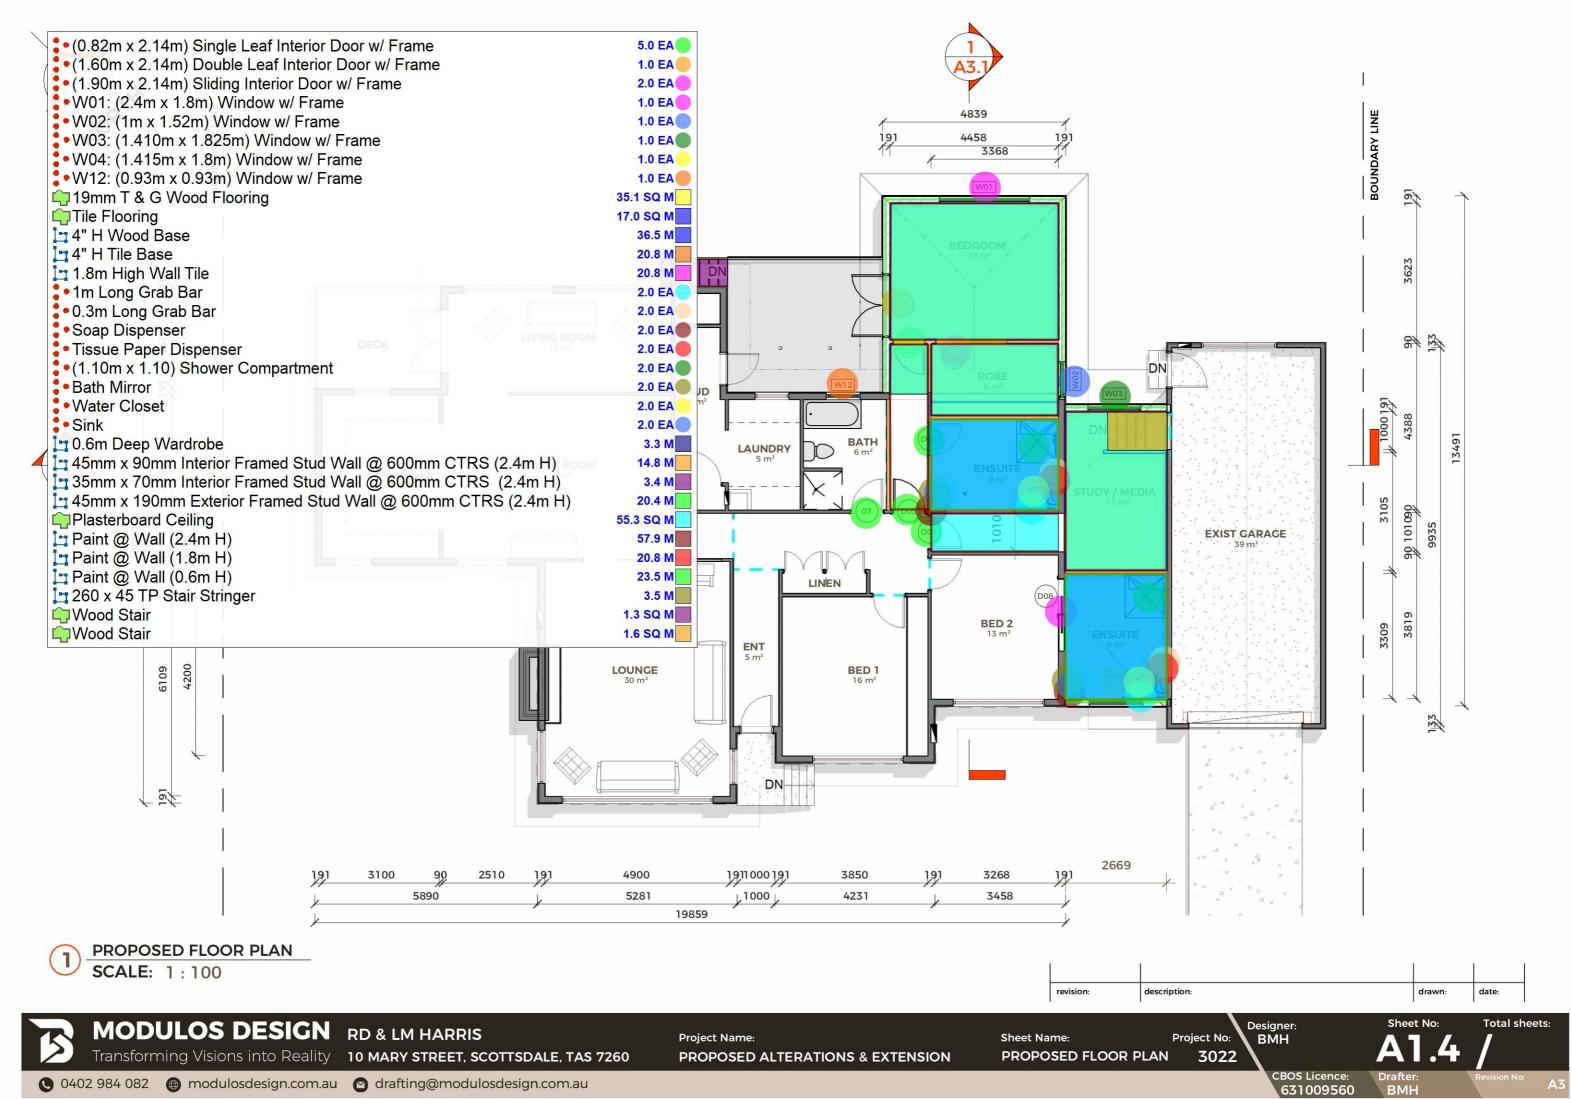


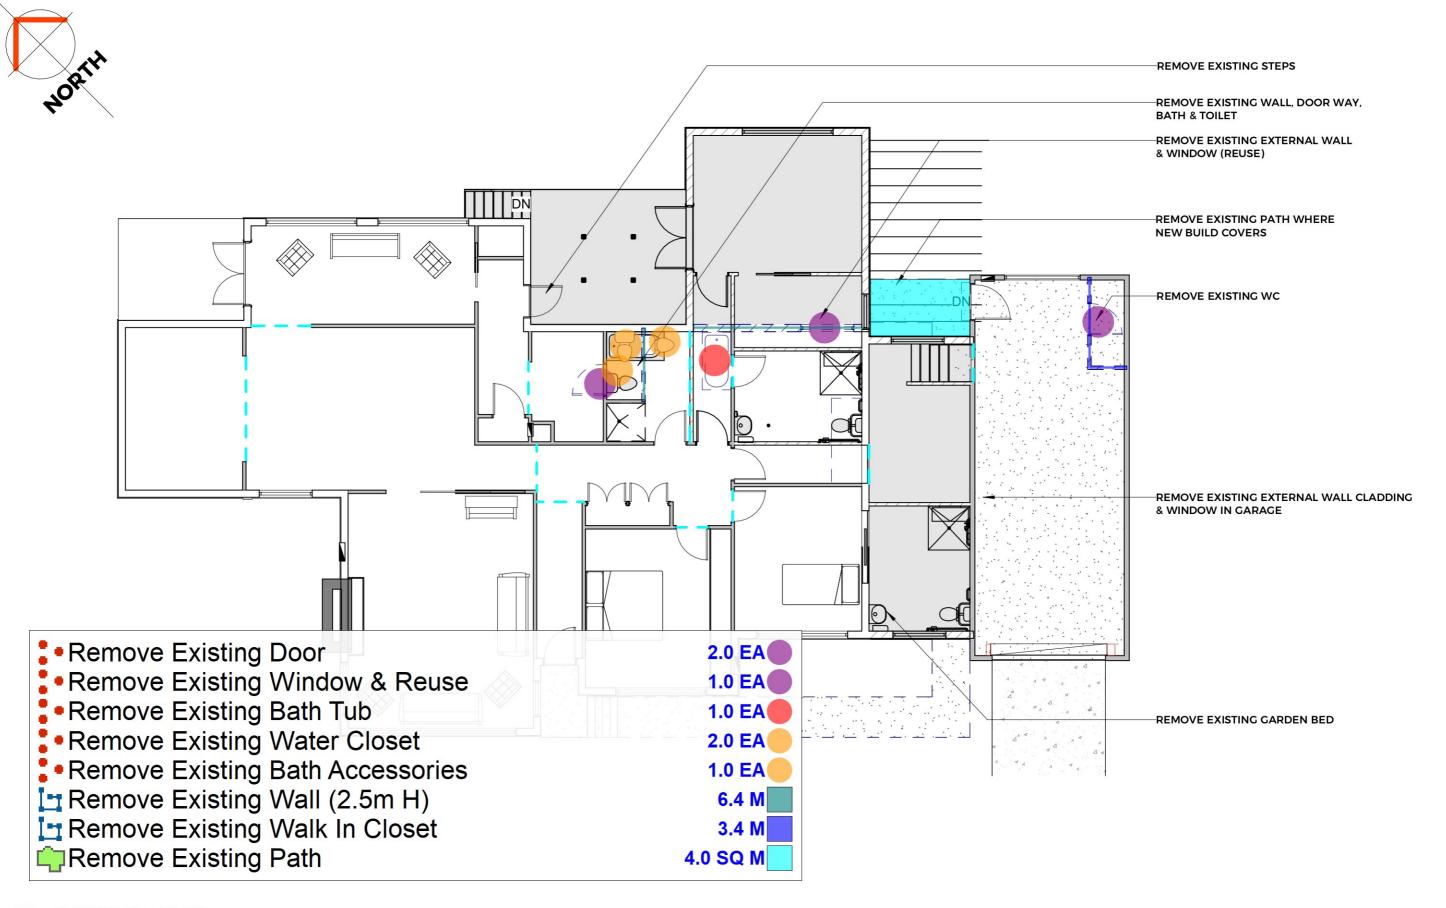

DEMOLITION PLAN
SCALE: 1:100

revision: description: drawn: date:



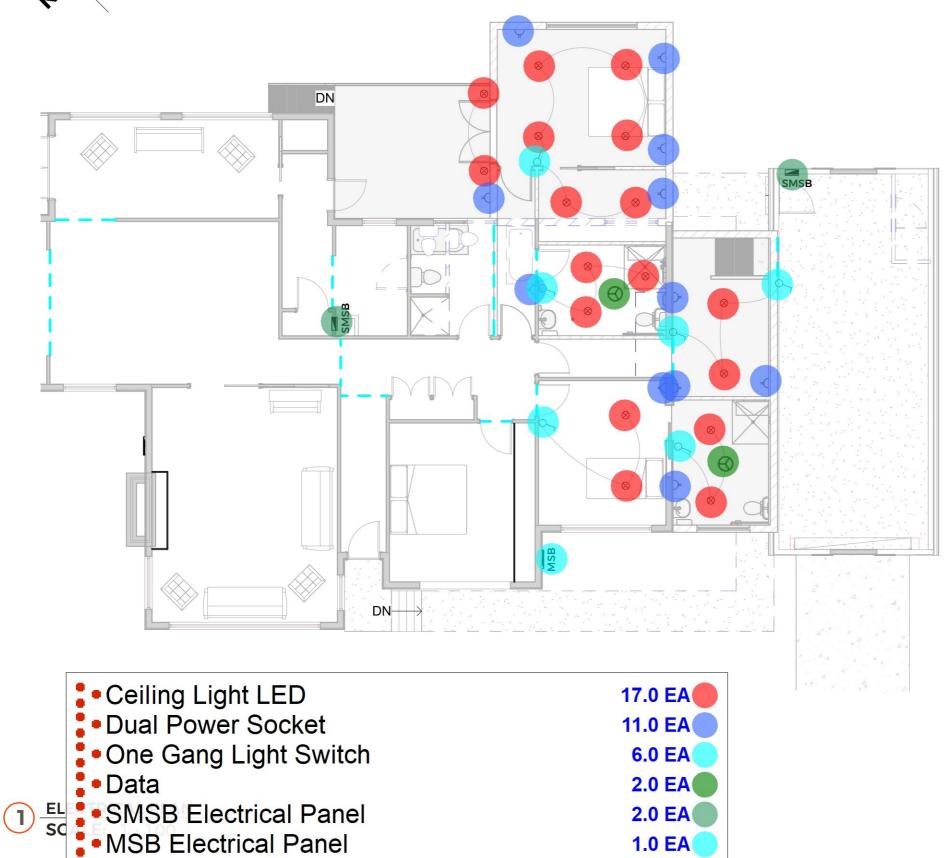

ELEC	TRICAL & MECHANICAL LEG	END	
MARK	COMPONENT	MODEL / DESCRIPTION	POWER
9	ONE GANG LIGHT SWITCH	CLIPSAL ICONIC FLUSH SERIES	
2	TWO GANG LIGHT SWITCH	CLIPSAL ICONIC FLUSH SERIES	
2	THREE GANG LIGHT SWITCH	CLIPSAL ICONIC FLUSH SERIES	
	FOUR GANG LIGHT SWITCH	CLIPSAL ICONIC FLUSH SERIES	
	DUEL POWER SOCKET	CLIPSAL ICONIC FLUSH SERIES	
~	DUEL POWER SOCKET INC. DATA	CLIPSAL ICONIC FLUSH SERIES	
△+D	DUEL POWER SOCKET OUTDOOR	CLIPSAL WATERPROOF SOCKET	
_	DOWNLIGHT	EMPRESS FIXED	15W
\otimes	CEILING LIGHT LED		
	HIGH BAY LIGHT	IES-LC2439 APOLLO	200W
\bigoplus	PENDANT LIGHT (ENERGY SAVER)	AS SELECTED	
	EXTERNAL MOUNTED FLOOD LIGHT	CLIPSAL INFRASCAN IP66	
\triangle	LED PANEL LIGHT	BLAIZE 1200 X 300	24W
Ю			
	LIGHT SWITCH DIMMER	CLIPSAL ICONIC FLUSH SER	IES
	MOTION SENSOR		
<u>+</u>	SMOKE ALARM		
S.	HEATED TOWEL RAIL	AS SELECTED	
Θ	COMBINATION LIGHT/FAN/HEATER	IXL TASTIC (OR SIMILAR)	
	CEILING FAN		
HTR	RANGE HOOD OVER HOT PLATES		
00	TV ANTENNA	CLIPSAL ICONIC SERIES	75 OHMS
	DATA		
	HEAT PUMP INTERNAL UNIT	DAIKIN	8KW
\rightarrow	HEAT PUMP EXTERNAL UNIT	DAIKIN	8KW
DATA	HOT WATER CYLINDER		250L
INV(I)	MAIN SWITCH BOARD		
INV(E)	SUB MAIN SWITCH BOARD		
HWC			
MSB			
SMSB			

ELECTRICAL NOTES

- 1. THIS PLAN IS DIAGRAMMATIC ONLY AND SUBJECT TO CHANGES BY THE ELECTRICIAN AND OWNER/S. THE BUILDING DESIGNER MUST BE CONTACTED IF EXTRA LIGHTING IS REQUIRED TO ENSURE THE LIGHTING CALCULATOR REQUIREMENTS ARE MET.
- 2. ELECTRICAL WORK MUST TO BE IN ACCORDANCE WITH AS

revision:	description:	drawn:	date:	

MODULOS DESIGN RD & LM HARRIS

Transforming Visions into Reality 10 MARY STREET, SCOTTSDALE, TAS 7260

Project Name:

PROPOSED ALTERATIONS & EXTENSION

Sheet Name:

ELECTRICAL PLAN


Project No: 3022

Designer:

Designer

Total sheets:

CBOS Licence: CC2319 H

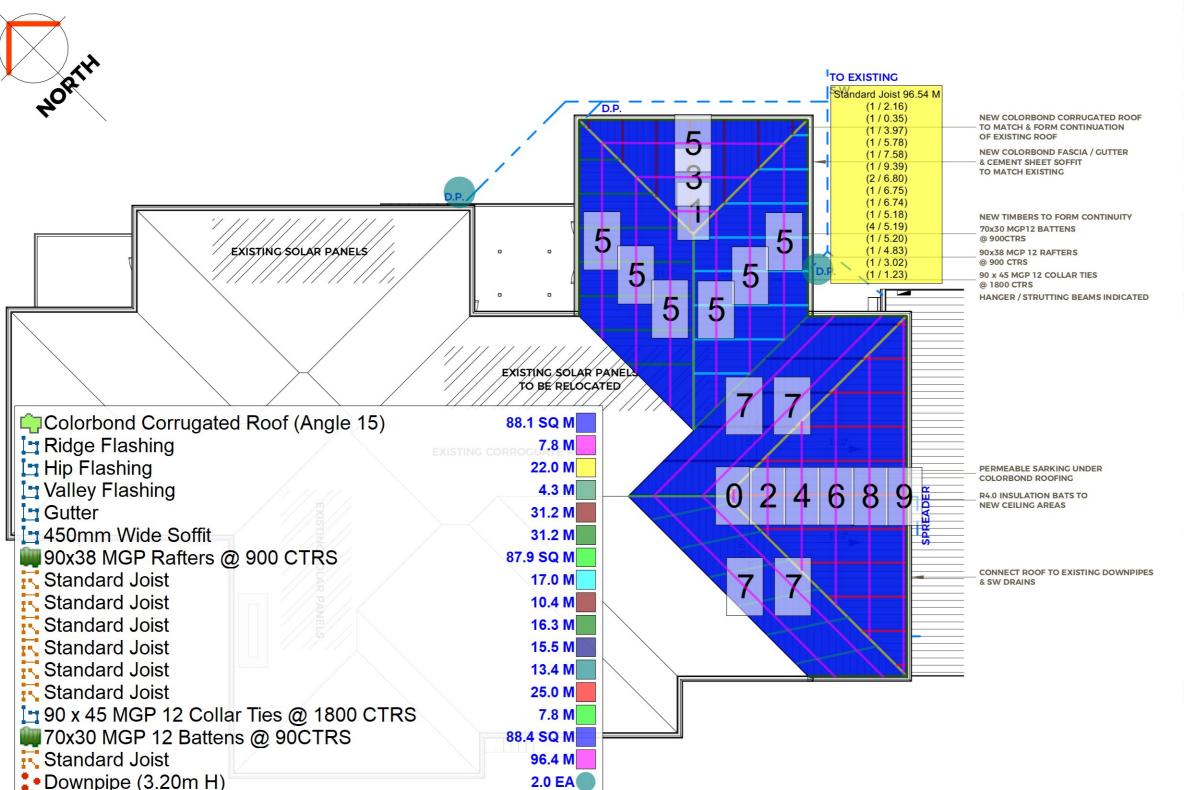

ROOF PLAN NOTES

ROOF CLADDING, GUTTERING AND DOWNPIPES:

In accordance with ABCB Housing Provisions Standard Part 7 and AS/NZS 3500.5.

Installation to be in accordance with manufacturer's specifications and recommendations

VENTILATION OF ROOF SPACES:

In accordance with ABCB Housing Provisions Standard Part 10.

HYDRAULIC:

Stormwater to be in accordance with AS/NSZ 3500 Wastewater to be in accordance with AS/NSZ 3500 and/or AS

Water supply to be in accordance with AS/NSZ 3500

CONSTRUCTION NOTES:

Construction and materials in accordance with current NCC requirements and all relevant Australian Standards - See **General Notes**

Construction in accordance with AS3959 = BAL 12.5

METAL ROOF

Metal sheeting roof to be installed in accordance with abcb housing provisions part 7.2. Refer to table 7.2.2a for acceptable corrosion protection for sheet roofing, refer to table 7.2.2b-7.2.2e for acceptability of contact between different

For fixing, sheet laying sequence, fastener frequency for tranverse flashings and cappings, anti capillary breaks, flashing details refer to abcb housing provisions part 7.2.5-7.2.7. Roof penetration flashing details.

Refer to to abcb housing provisions part 7.2.5- 7.2.7. Roof sheeting must overhang min 35mm as per abcb housing provisions part 7.2.8

EAVE & SOFFIT

NCC Volume 2 Part 3.5.3.5

Eave width - 300mm design wind speed N3 Soffit / eave lined with 'hardiflex' cement sheeting

Trimmers located within 1200 mm of external corners to be spaced @ 500 mm centers, remainder of sheet - 700 mm

Fastener / fixings within 1200 mm of external corners @ 200 mm centers, remainder of sheet - 300 mm centers

ROOF NOTES

VAPOUR PERMEABLE SARKING UNDER BATTENS (OR EQUIV.)(WITH 25MM AIR GAP TO ROOFING) AND A MINIMUM 10MM ROOF VENTILATION (SUPPLY) GAP IN ACCORDANCE WITH NCC.

RIDGE TO HAVE CONTINUOUS GAP IN VAPOUR PERMEABLE SARKING (5MM) OR EQUIV. VENTILATION SYSTEM(EXHAUST) IN ACCORDANCE WITH NCC.

SELECT COLORBOND CAPPING AND FLASHINGS INSTALLED TO MANUFACTURERS SPECIFICATION.

FC LINING TO EAVE WITH EAVE VENTS FOR VENTILATION (OR EQUIV) IN ACCORDANCE WITH NCC.





MODULOS DESIGN RD & LM HARRIS

Transforming Visions into Reality 10 MARY STREET, SCOTTSDALE, TAS 7260

PROPOSED ALTERATIONS & EXTENSION

Sheet Name: ROOF PLAN Project No: 3022

вмн

CBOS Licence: 631009560 **Total sheets:**

